



9/11/13



APE ARCHITECT
JEORNIA 94521

REVISIONS

JAMES SWANSON - LANDSCAPE ARCHIT 5100-1B CLAYTON ROAD #186 - CONCORD, CALIFORNIA 94521 PHONE: (925) 673-9040 FAX: (925) 673-9047

LUCAS RANCH ESTATES TRACT #6569 LAFAYETTE, CALIFORNIA

LANDSCAPE PLAN

GRAPHIC SCALE

(IN FEET) 1 inch = 30 ft.

NORTH

LANDSCAPE PLAN

DATE: 8/25/08

JOB NO:

JOB NO:

SCALE: 1"=30'

DRAWN BY: JRS

L-2

SHEET:

L-Z

of sheets

NUMBER TREES (TO BE 15 GALLON SIZE, EXCEPT AS NOTED ON PLAN) 2-15 GALLON, 3-24" BOX, 3-36" BOX, 2-48" BOX COAST LIVE OAK QUERCUS AGRIFOLIA QUERCUS LOBATA VALLEY OAK 1-15 GALLON

SHRUBS (TO BE 5 GALLON SIZE, EXCEPT WHERE NOTED ON PLAN)

382-5 GALLON **MUHLENBERGIA RIGENS** DEER GRASS

CITY STANDARD OPEN SPACE WILDFLOWER MIX

HYDROSEEDED MIX SHALL CONSIST OF THE FOLLOWING: 30% CALIFORNIA BROME 30% MEADOW BARLEY 20% ZORRO ANNUAL FESCUE

10% PURPLE NEEDLE GRASS 10% CALIFORNIA COVER NATIVE FLOWER MIX

HYDROSEED SLURRY SHALL CONTAIN 60 POUNDS OF SEED PER ACRE; 2000 POUNDS OF WOOD FIBER PER ACRE; 3000 POUNDS OF FERTILIZER (16-20-0) PER ACRE. STABILIZING EMULSION SHALL BE MBINDER OR EQUIVALENT. HYDROSEEDING SHALL BE COMPLETED NO EARLIER THAN OCTOBER 1 AND NO LATER THAN COTOBER 31.

MIX CAN BE SECURED THROUGH: PACIFIC COAST SEED, INC. LIVERMORE,C ALIFORNIA

CONTACT: DAVID GILIPIN. PHONE: (925) 373-4417

PLANT MATERIAL NOTE

WHILE EVERY EFFORT HAS BEEN MADE TO SELECT PLANTS THAT DEER AVOID, DEER IF HUNGRY, WILL EAT ALMOST ANY PLANT. THEREFORE, THE LANDSCAPE ARCHITECT SHALL BE HELD HARMLESS IF PLANTS ARE DESTROYED OR DAMAGED BY DEER. PLANTS SHALL BE PROTECTED AS REQUIRED WITH WIRE SCREEN FENCING OR OTHER APPROVED METHODS FROM DEER BROWSING.

PLANTING NOTES

1. LANDSCAPE CONTRACTOR SHALL FAMILIARIZE HIMSELF WITH THE SITE PRIOR TO SUBMITTING HIS BID. IF OBSTRUCTIONS, LANDSCAPE AREAS,

OR GRADING DIFFERENCES EXIST, HE SHALL IMMEDIATELY INFORM THE LANDSCAPE ARCHITECT AND NOT PROCEED. CONTRACTOR SHALL BE FAMILIAR WITH

ALL UNDERGROUND UTILITIES, PIPES, OBSTRUCTIONS AND STRUCTURES AND SHALL TAKE RESPONSIBILITY IF THESE ARE DAMAGED BY HIM.

PLANTING SHALL BE INSTALLED IN CONFORMANCE WITH ANY APPLICABLE CODES AND ORDINANCES.

2. ALL SLOPES 3:1 OR GREATED SHALL HAVE JUTTE MESH EROSION CONTROL FABRIC.

3. TREE, SHRUB AND GROUND COVER PLANTING TO BE ACCORDING TO DETAILS.

4. CONTRACTOR SHALL GUARANTEE TREES FOR A PERIOD OF 1 YEAR, SHRUBS FOR 6 MONTHS, AND GROUND COVER FOR 3 MONTHS, AND SHALL MAINTAIN INSTALLATION

FOR A 90 DAY PERIOD AFTER FINAL APPROVAL, AT THE END OF THE MAINTENANCE PERIOD ALL MATERIAL SHALL BE IN A HEALTHY AND TRIVING CONDITION AND WEED FREE.

PLANT MATERIALS LIST & NOTES

REVISIONS

PLANT LIST NOTES


DATE: 3/30/09

JOB NO:

SCALE: NTS

SHEET:

L-3 OF SHEETS

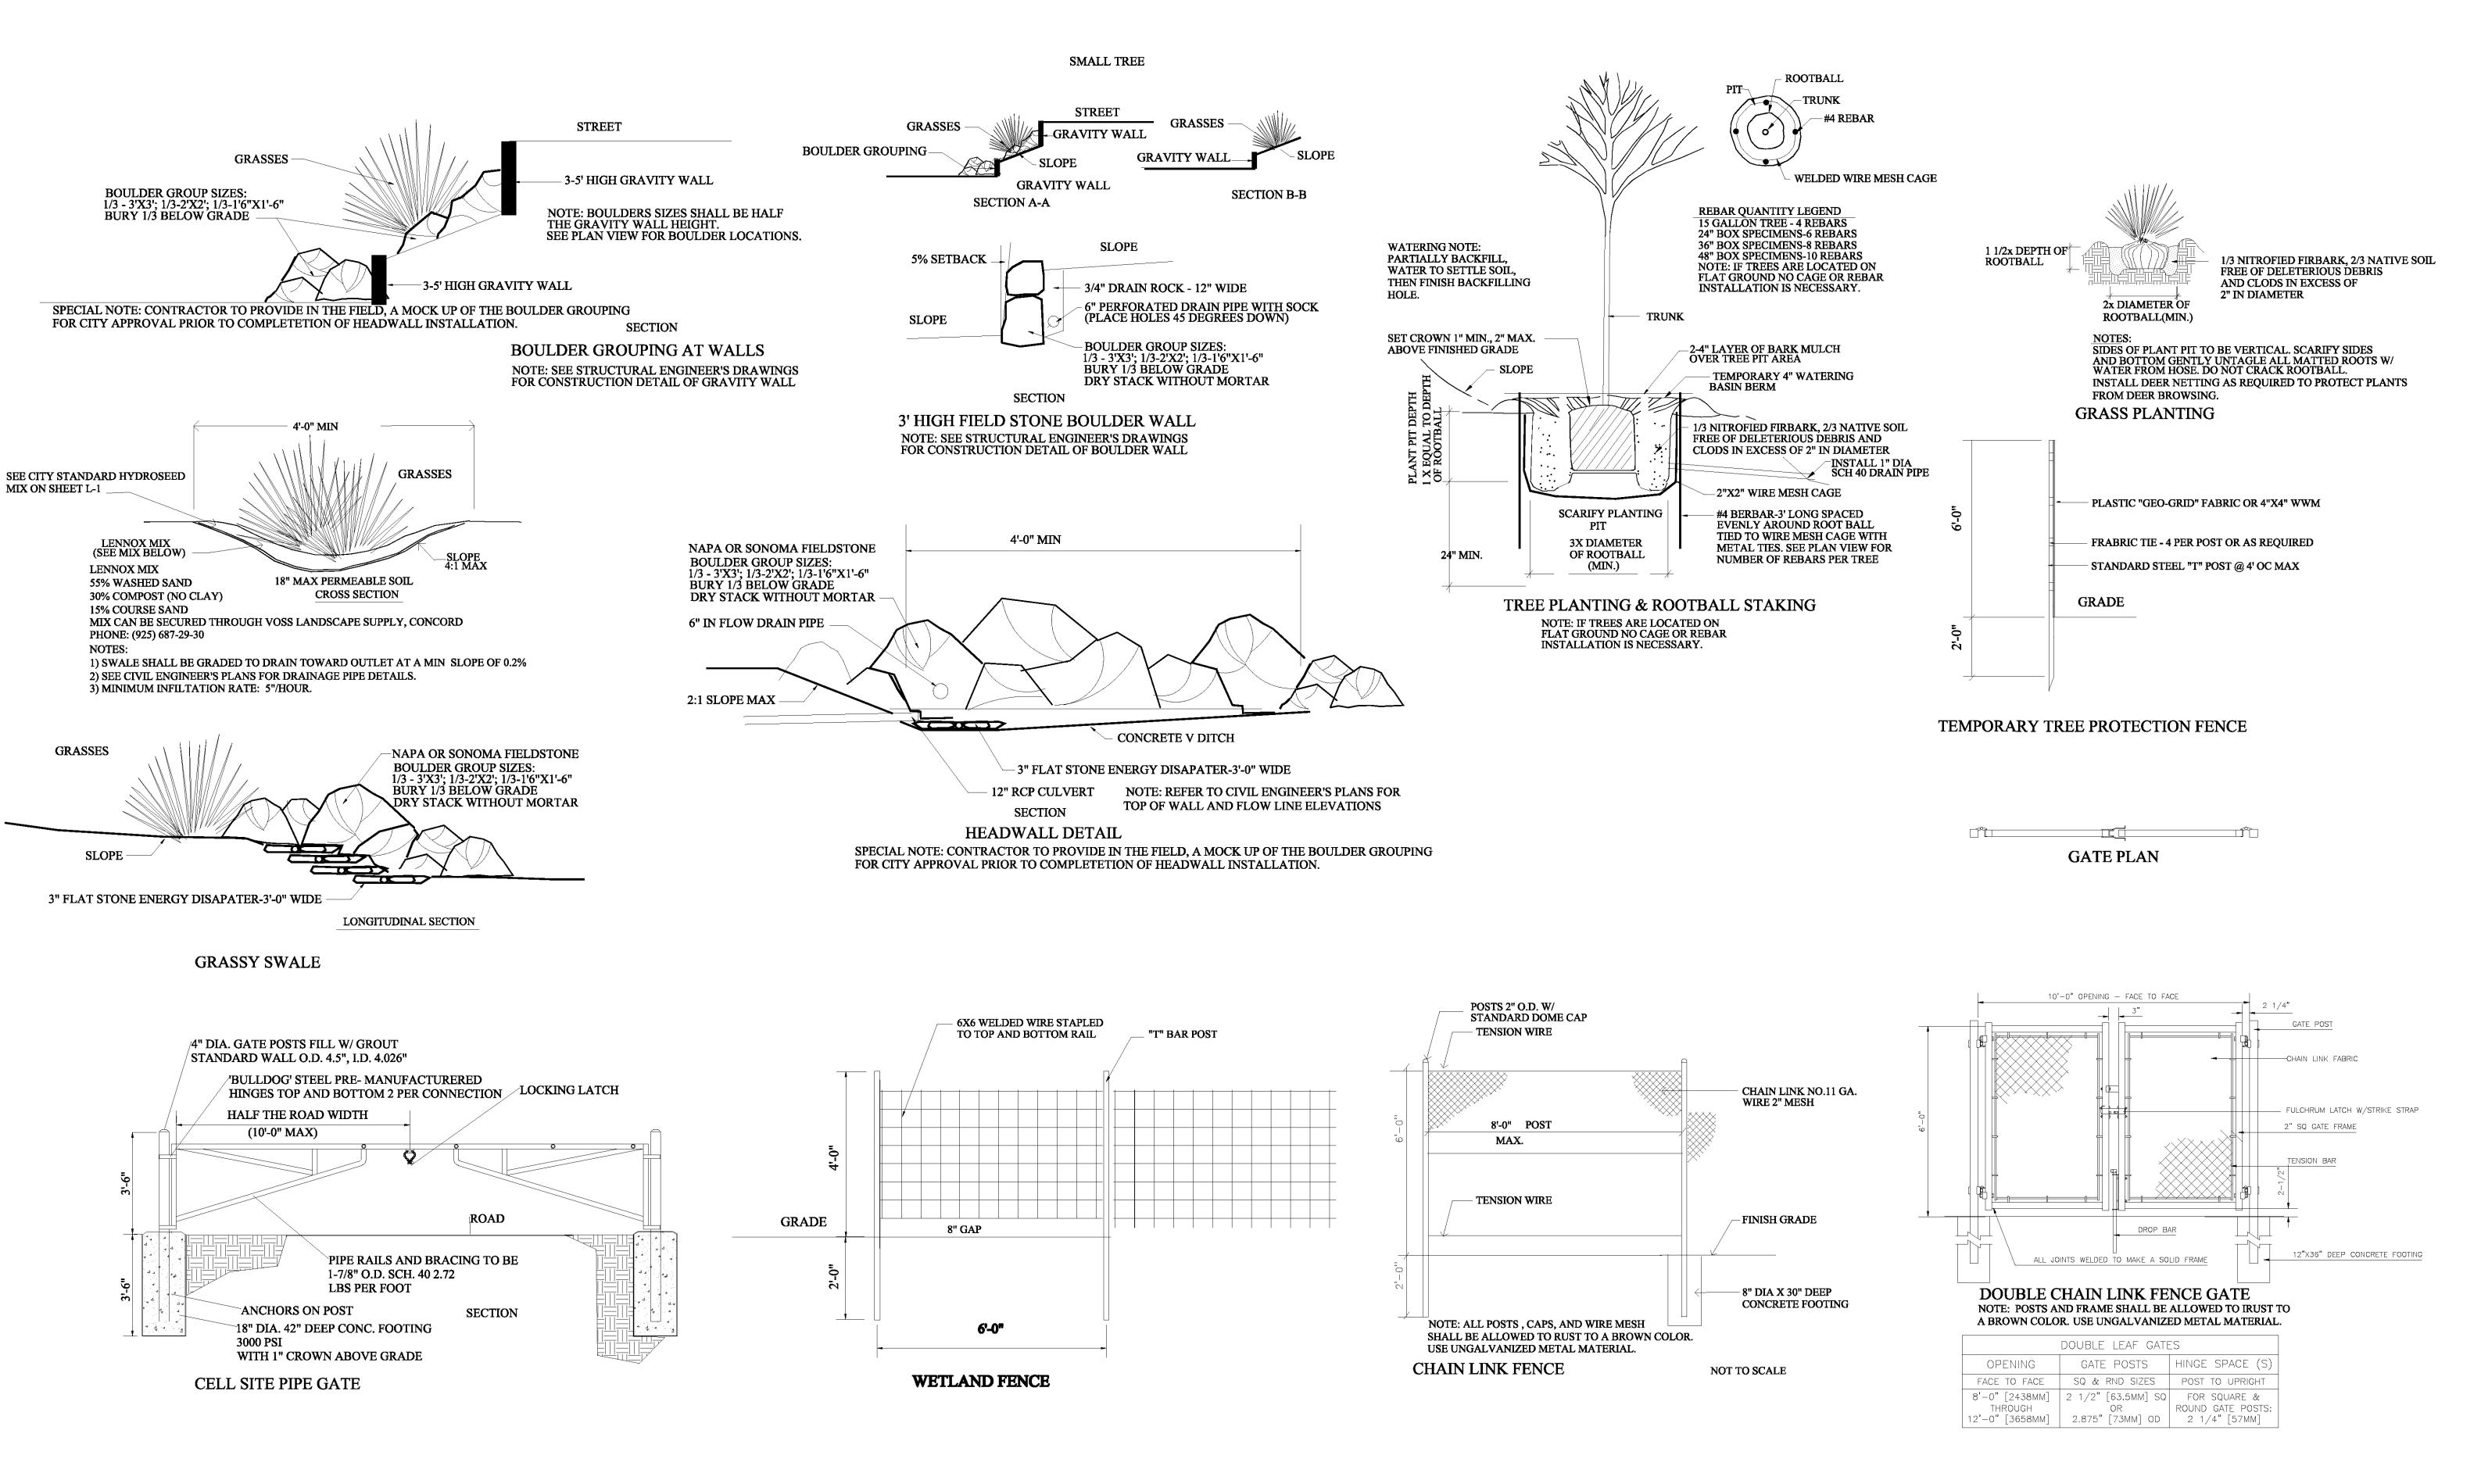

INSTALLATION DETAILS

ESTATES


ALIFORNI

REVISIONS

DATE: 1/9/09 JOB NO: SCALE: NTS

DRAWN BY: JRS SHEET:

SEE SHT I-2

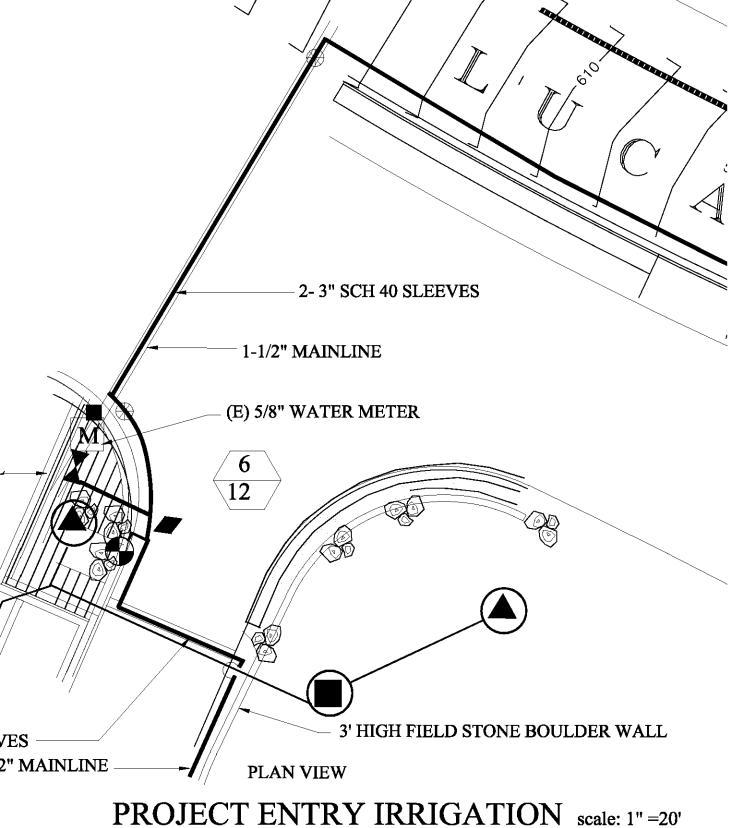

		Huddillon EEGEND		
	SYMBOL	NUMBER	DESCRIPTION	
	·	DL-2000 RPG 4 18	TORO INLINE DRIPLINE WITH 18" EMITTER SPACING FOR GROUND COVERS @ 1.02 GAL/HR	
4' dia 15 GALLON	6' dia BOX SPECIMENS	DL-2000 RGP 4 12	TORO INLINE DRIPLINE WITH 12" EMITTER SPACING FOR TREES @ 1.02 GAL/HR	
		SCH 40-3/4"	LASCO PVC LATERAL LINE PIPE FOR DRIP SYSTEM	
	•	TLO 50 MPV-1	NETA-FIM AUTOMATIC FLUSH VALVE	
	-	TLAVRV	TORO AIR VENT/ VACUUM RELIEF VALVE WITH MANUAL FLUSH	
	•	XCZ-100-BFF	RAINBIRD AUTOMATIC CONTROL VALVE, WITH FILTER, AND INLINE PRESSURE REGULATOR	
	•	44 DRC	RAINBIRD 1" QUICK COUPLER VALVE	
	<u>(C)</u>	SCH 40 1-1/2"	LASCO PVC MAINLINE PIPE	
		4008	LEIT 8 STATION SOLAR CONTROLLER	
		SCH 40	6" PVC SLEEVE WITH 24" OF COVER	
	H	825Y-BV-1"	FEBCO REDUCED PRESSURE BACKFLOW PREVENTION DEVICE W/ LEMUR ENCLOSURE & POLAR BLANKET	
	FLOW	KC SERIES AT LINE SIZE	KBI OR EQUAL SPRING CHECK VALVE	
	₩	LINE SIZE	NIBCO OR EQUAL ISOLATION BALL VALVE	
	$oldsymbol{M}$		EXISTING 5/8" WATER METER	
	$\left\langle \frac{1}{7} \right\rangle$	— VALVE DESIGNATION — GPM		



IRRIGATION PLAN NOTE: SEE SHEET L-4 FOR DEATILS

REVISIONS

ESTATES


IRRIGATION PLAN

DATE: 9/9/09

JOB NO: SCALE: 1"=30'

DRAWN BY: JRS SHEET:

OF SHEETS

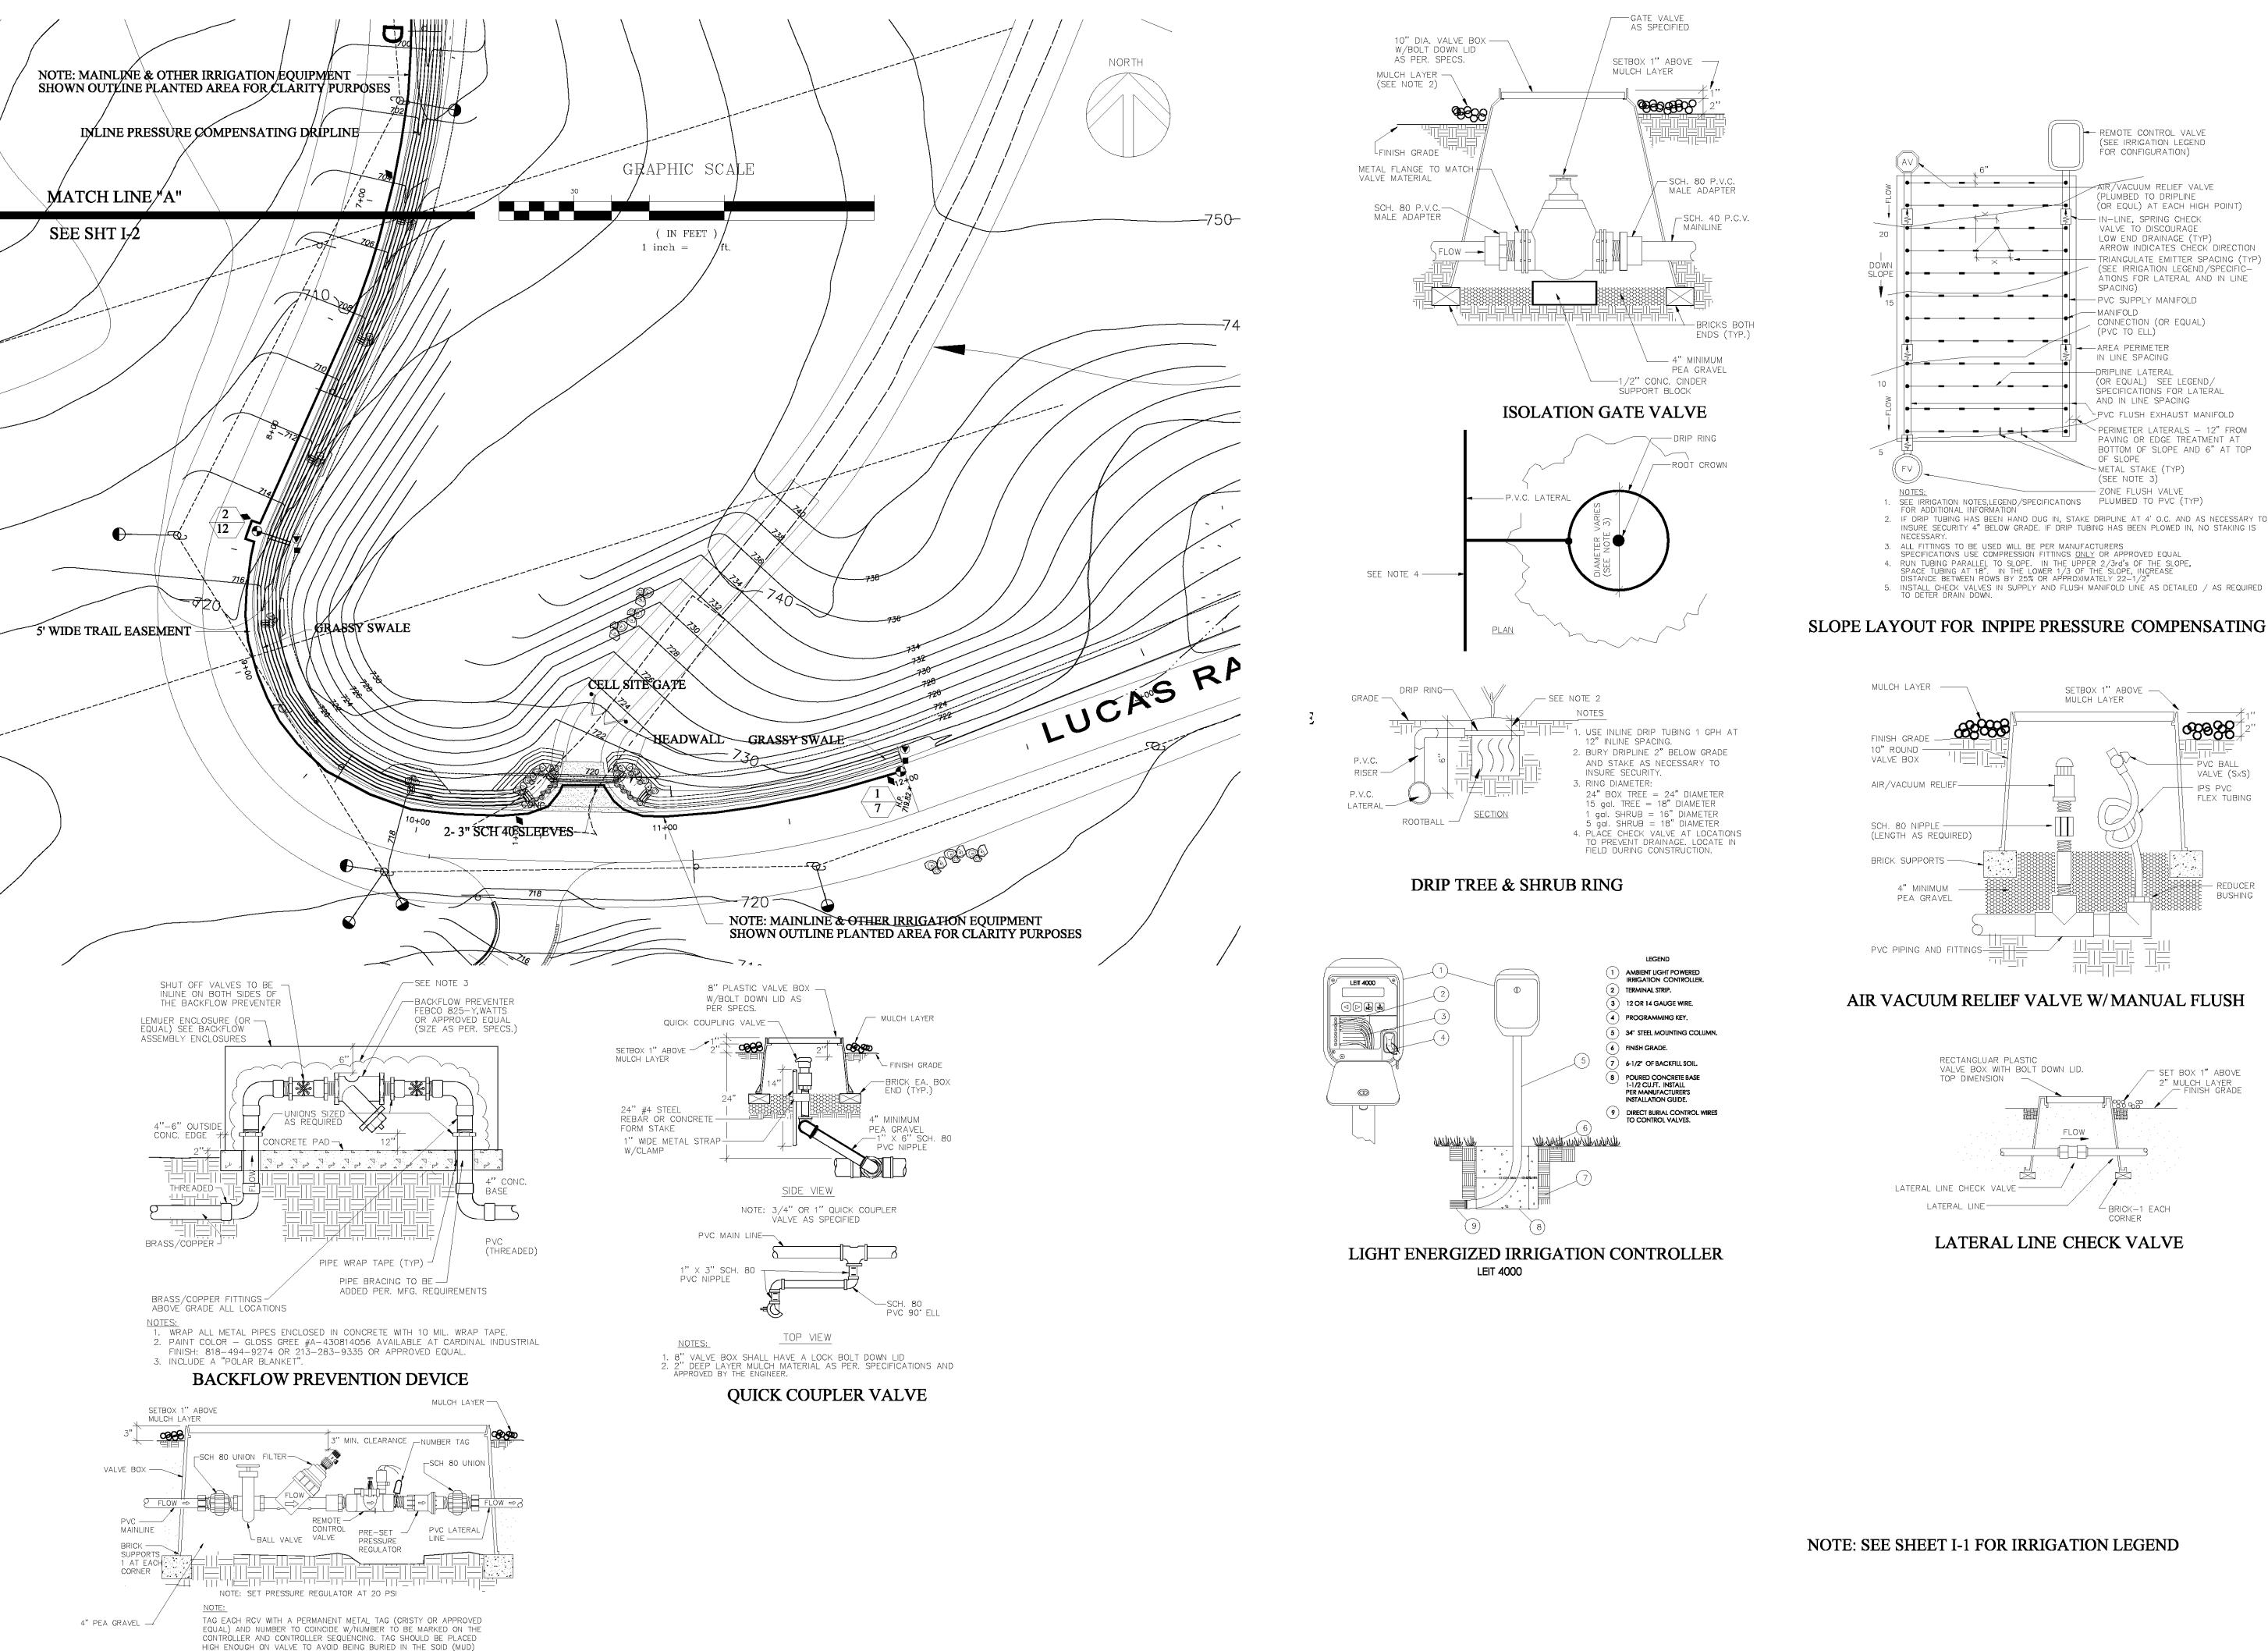


DRIP SYSTEM PRESSURE REGULATING VALVE


& FILTER ASSEMBLY

REMOTE CONTROL VALVE (SEE IRRIGATION LEGEND FOR CONFIGURATION) ATR/VACUUM RELIEF VALVE (PLÚMBED TO DRIPLINE (OR EQUL) AT EACH HIGH POINT) - IN-LINE, SPRING CHECK VALVE TO DISCOURAGE LOW END DRAINAGE (TYP) ARROW INDICATES CHECK DIRECTION - TRIANGULATE EMITTER SPACING (TYP) (SEE IRRIGATION LEGEND/SPECIFIC-ATIONS FOR LATERAL AND IN LINE PVC SUPPLY MANIFOLD CONNECTION (OR EQUAL) AREA PERIMETER IN LINE SPACING -DRIPLINE LATERAL (OR EQUAL) SEE LEGEND/ SPECIFICATIONS FOR LATERAL AND IN LINE SPACING PVC FLUSH EXHAUST MANIFOLD PERIMETER LATERALS - 12" FROM PAVING OR EDGE TREATMENT AT
BOTTOM OF SLOPE AND 6" AT TOP -METAL STAKE (TYP) - ZONE FLUSH VALVE 1. SEE IRRIGATION NOTES, LEGEND/SPECIFICATIONS PLUMBED TO PVC (TYP) FOR ADDITIONAL INFORMATION 2. IF DRIP TUBING HAS BEEN HAND DUG IN, STAKE DRIPLINE AT 4' O.C. AND AS NECESSARY TO INSURE SECURITY 4" BELOW GRADE. IF DRIP TUBING HAS BEEN PLOWED IN, NO STAKING IS 3. ALL FITTINGS TO BE USED WILL BE PER MANUFACTURERS
SPECIFICATIONS USE COMPRESSION FITTINGS ONLY OR APPROVED EQUAL
4. RUN TUBING PARALLEL TO SLOPE. IN THE UPPER 2/3rd's OF THE SLOPE,
SPACE TUBING AT 18". IN THE LOWER 1/3 OF THE SLOPE, INCREASE
DISTANCE BETWEEN ROWS BY 25% OR APPROXIMATELY 22-1/2"

SLOPE LAYOUT FOR INPIPE PRESSURE COMPENSATING DRIPLINE

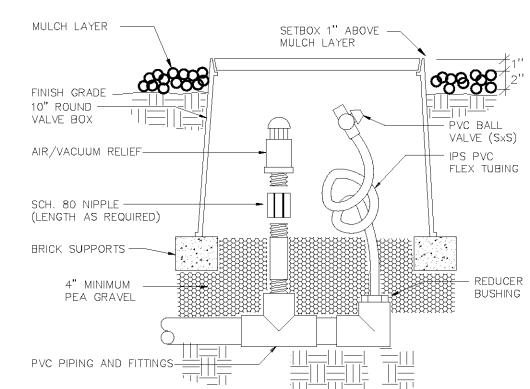

AIR VACUUM RELIEF VALVE W/MANUAL FLUSH

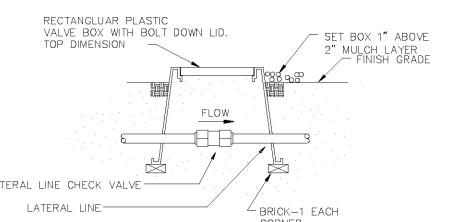

IRRIGATION PLAN

REVISIONS BY

H

IRRIGATION PLAN

DATE: 1/9/09

JOB NO:

SCALE: 1"=30" DRAWN BY: JRS SHEET:

OF SHEETS